



SOUTH ELEVATION
SCALE 1:100

PRECAST REINFORCEMENT SCHEDULE

PANELS	THICKNESS	FABRIC	VERT. REINF.	HORIZ. REINF.	PERIMETER BARS	DOWELS BTM. EDGE*
P1	200	SL92 EF	-	-	N16 EF	D2-500 CTS
P2	150	SL102 CENTRAL	-	-	=	D2-500 CTS
P3	150	-	N12-200 CENTRAL	N12-200 CENTRAL	=	D2-500 CTS
P4	150	-	N16-200 CENTRAL	N16-200 CENTRAL	=	D2-500 CTS
P4a	150	-	N16-200 CENTRAL	N16-200 CENTRAL	=	D3-400 CTS
P4b	150	-	N16-200 CENTRAL	N16-200 CENTRAL	=	D4-400 CTS
P5	150	-	N20-200 CENTRAL	N20-200 CENTRAL	=	D3-400 CTS
P5a	150	-	N20-200 CENTRAL	N20-200 CENTRAL	=	D4-400 CTS
P6	200	-	N12-200 EF	N12-200 EF	=	D3-400 CTS
P6a	200	-	N12-200 EF	N12-200 EF	=	D2-500 CTS
P7	200	-	N16-200 EF	N16-200 EF	=	D4-400 CTS
P7a	200	-	N16-200 EF	N16-200 EF	=	D3-400 CTS
P8	200	SL92 EF	-	-	=	D2-500 CTS
P9	200	-	N20-200 EF	N20-200 EF	=	D4-400 CTS

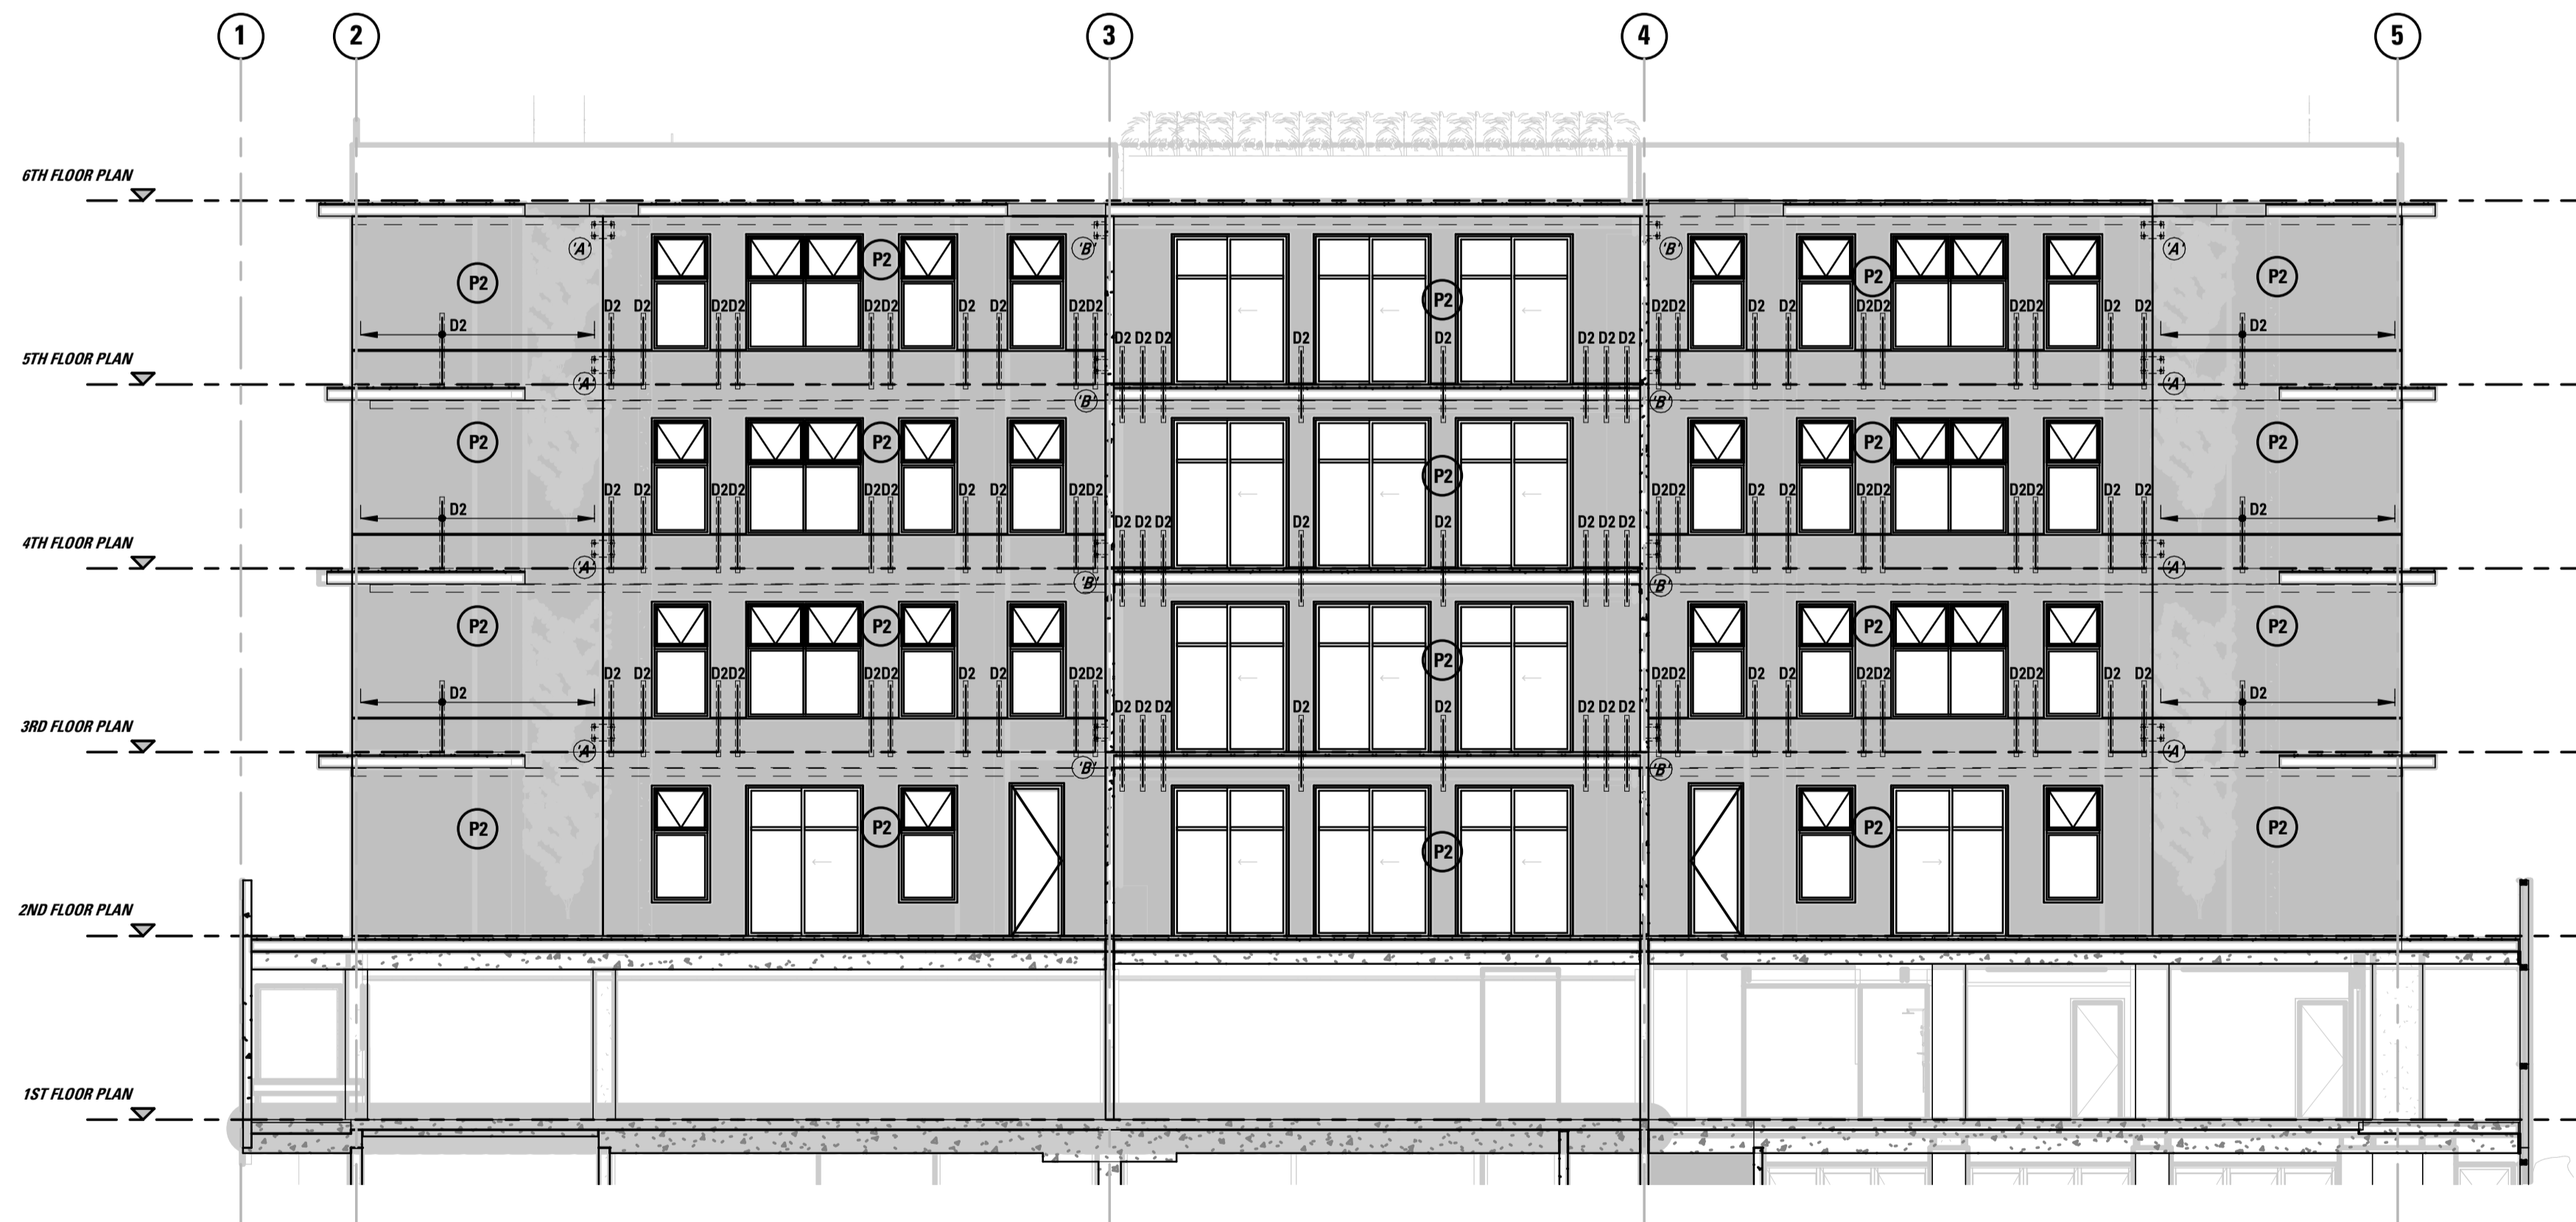

EXTERNAL PRECAST ELEVATION ALONG GRID F
SCALE 1:100

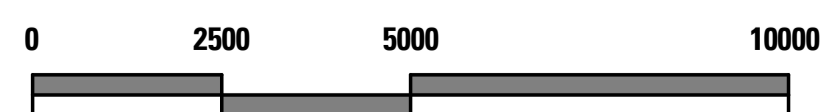

SCALE 1:100 @ A1

TENDER ISSUE

02.07.19				ISSUED FOR TENDER				T			
Date				Revision				Issue			
PT Design											
PT Design Associates Pty Ltd 141-149 Hould St Adelaide SA 5000 T [08 8412 4300] F [08 8232 4311] E [ptdesign@ptdesign.net.au]											
Designer		RW		Drawn		SZ & MM		Approved		Approver	
Date		02/07/2019		1:01:46 PM		STRUCTURAL		Sheet		10 of x	
Project											
HYDE PARK PLACE 248 UNLEY ROAD, HYDE PARK SA											
Client										N +	
CITYFY & BFC PTY LTD											
Drawing Title										Scale	
EXTERNAL ELEVATIONS (Sheet 2)										As indicated	
Drawing Number										Issue	
20492-S13										T	